


\*Preliminary – Not for Construction\*

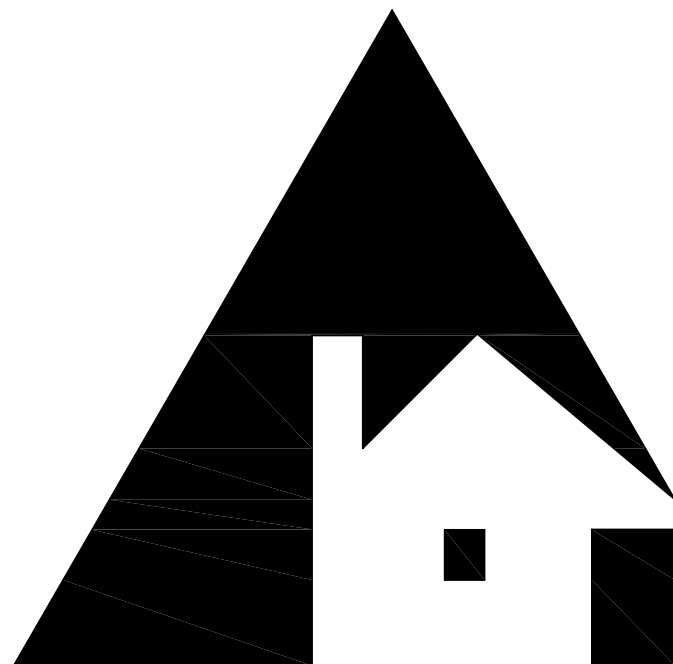

# Riverbend Log Homes

A Division Of Phoenix Wood Products

79 Carleton Drive, Nackawic, N.B., E6G 1W2,

Tel: 1-800-561-3000, Fax: 506-575-2855

[www.riverbendloghomes.com](http://www.riverbendloghomes.com)

Client: Standard Bedford

Building Style: -----

Drawn By: DB

Project No.: 2006-000

Revision No.: 0

## \*Notes:

\*The following notes apply but are not limited to all pages of this document.

-The owner accepts full responsibility to ensure that all persons involved in the installation are trained and have adequate knowledge of construction practices in accordance with current Building Codes and Engineering Specifications.

-Proper care must be taken in Handling & Storage of materials.

-Riverbend Log Homes will not be held accountable for material shortages, lost time, damaged or stolen property due to improper installation or irresponsibility of the owner, contractor, or other persons involved.

-All foundation and subfloor materials are the responsibility of the owner. Structural Members including Foundation, Footings, Columns and Beams are to conform to local codes and approved by a Professional Engineer.

-Fireplace/Chimney size and location are to be specified by owner and noted on approval drawings.

-Before applying stain, log surfaces must be sanded or washed with a mill-glaze removal solution. Contact Riverbend for a pamphlet on proper Log Home Preserving and Maintenance methods.

-Before starting construction, the builder/owner must review and be responsible for all details and dimensions, and ensure the plan conforms to all local building codes. Any errors or omissions to be reported to draftsperson before construction.

-Riverbend Log Homes is obliged to consult on the construction of the components provided in the log home kit. Consultation on any other aspect such as foundation, will be a matter of opinion and not considered a Professional Service.

-Dimensions govern over scale.

\*Preliminary – Not for Construction\*




Front Elevation



Right Elevation



Back Elevation

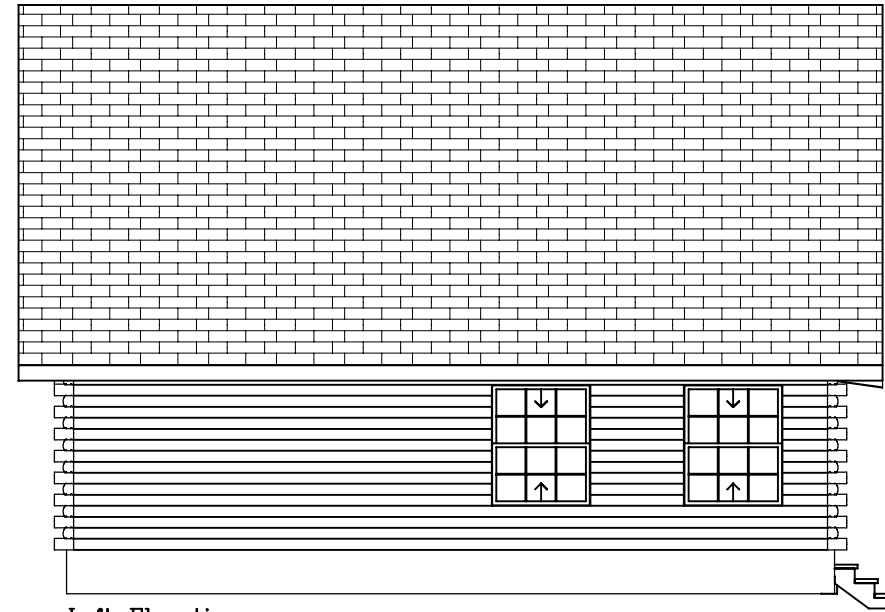

Left Elevation

PROJECT NO: 2006-000  
DATE: Jan. 09, 2006  
SHT SUBSET: 3D Reqs & Elevs  
DRAWN BY: DB  
CHK'D BY: |REV. NO: 0  
SCALE: N.T.S.

**Riverbend Log Homes**  
P: 1-800-561-3000  
P: 1-506-575-2255  
F: 1-506-575-2855  
www.riverbendloghomes.com


PROJECT NAME:  
Standard Bedford

BLDG. STYLE:  
-----

SHEET TITLE:  
Elevations

SHEET NO:  
A1

\*Preliminary – Not for Construction\*

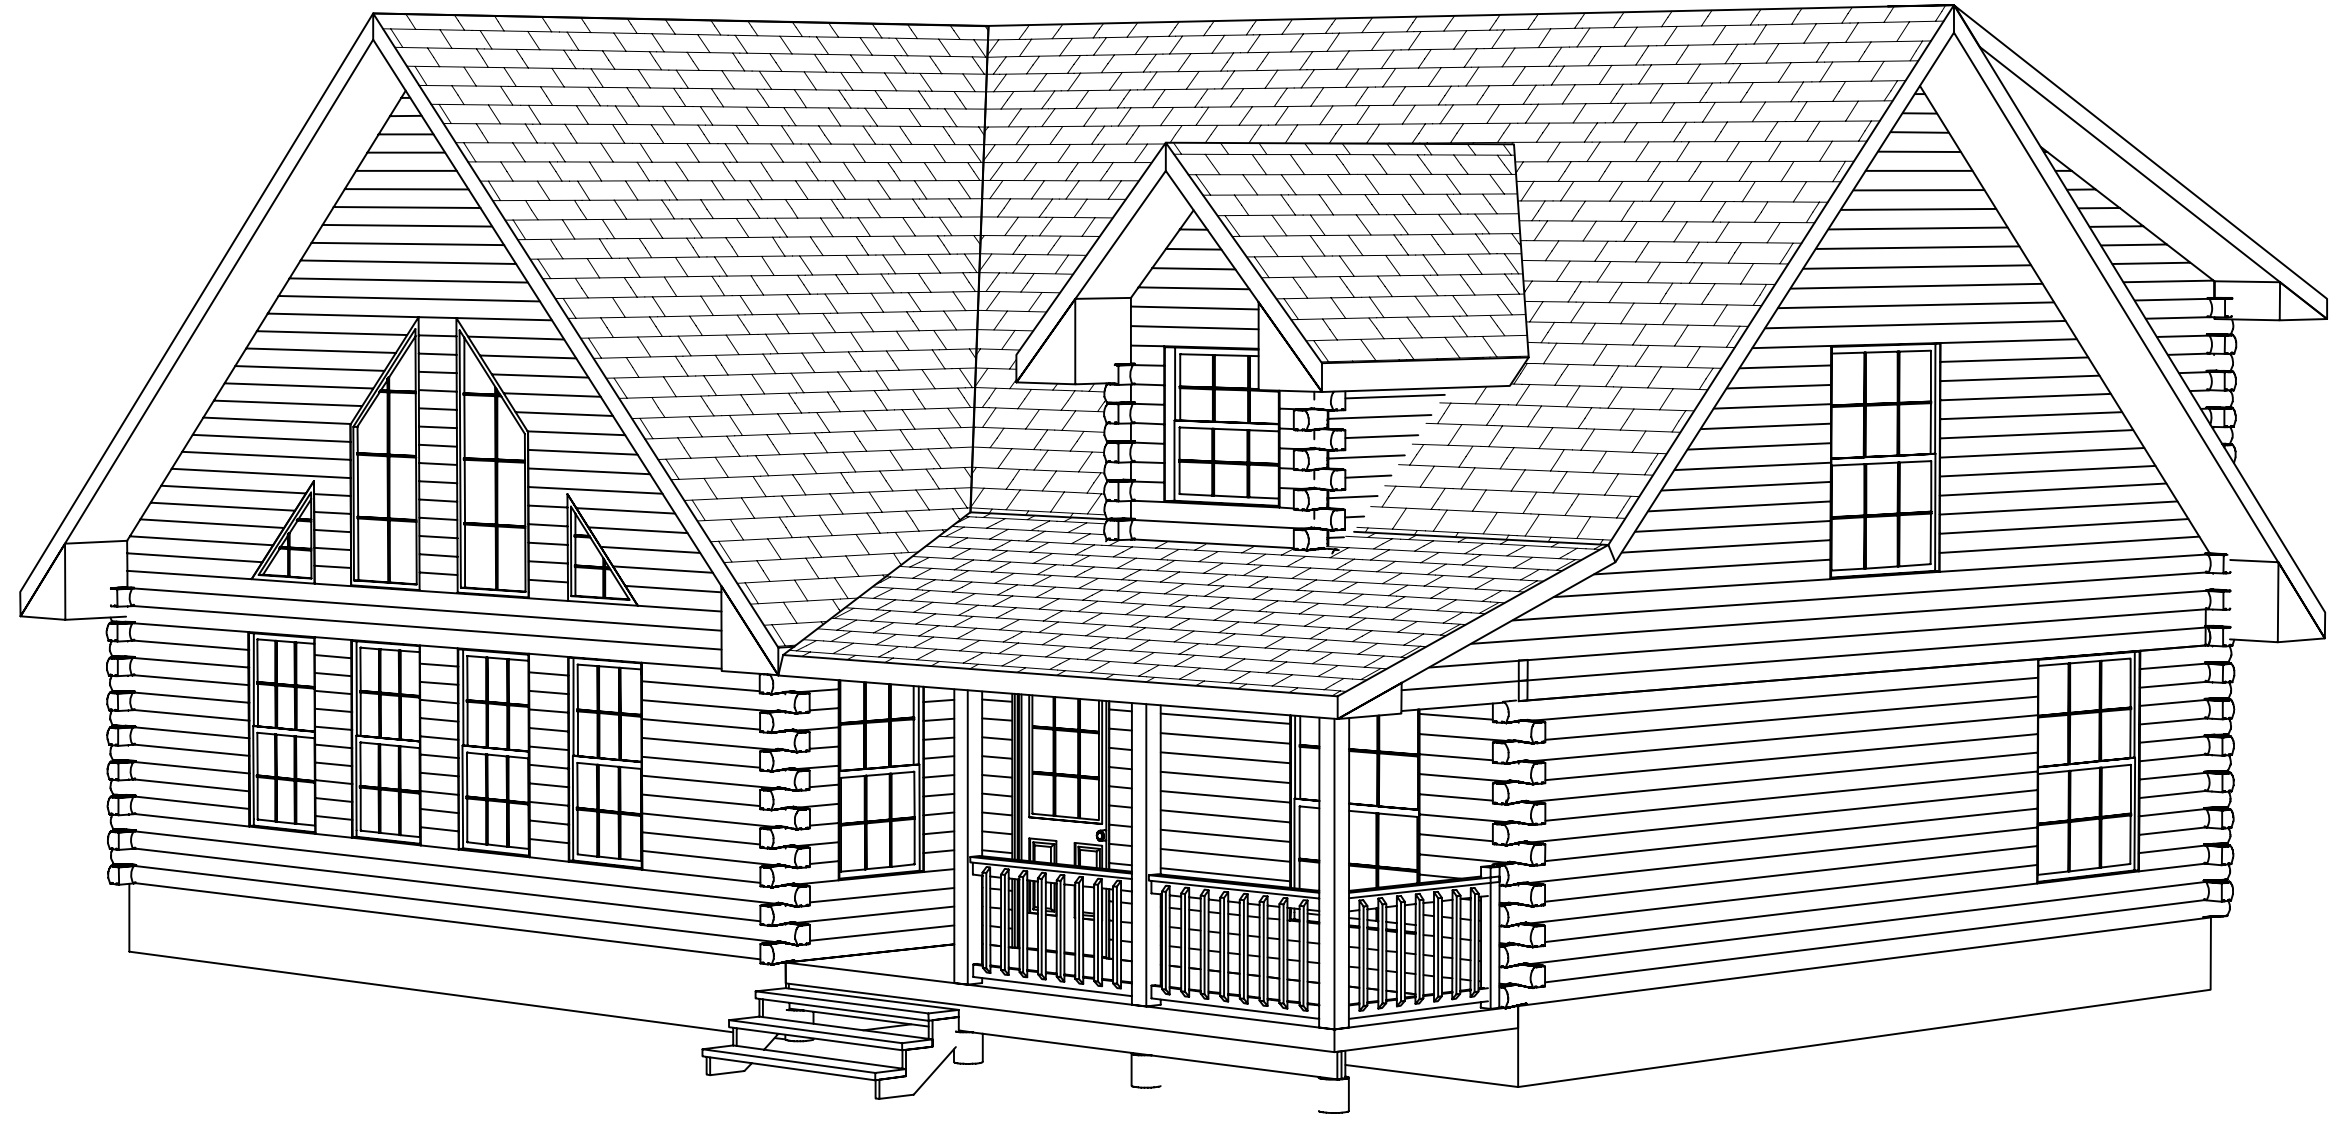

PROJECT NO: 2006-000  
DATE: Jan. 09, 2006  
SHT SUBSET: 3D Reqs & Elevs  
DRAWN BY: DB  
CHK'D BY: |REV. NO: 0  
SCALE: N.T.S.




Riverbend Log Homes  
P:1-800-561-3000  
P:1-506-575-2255  
F:1-506-575-2855  
www.riverbendloghomes.com

PROJECT NAME: Standard Bedford  
BLDG. STYLE: -----


SHEET TITLE: 3D View

SHEET NO: A2

\*Preliminary – Not for Construction\*

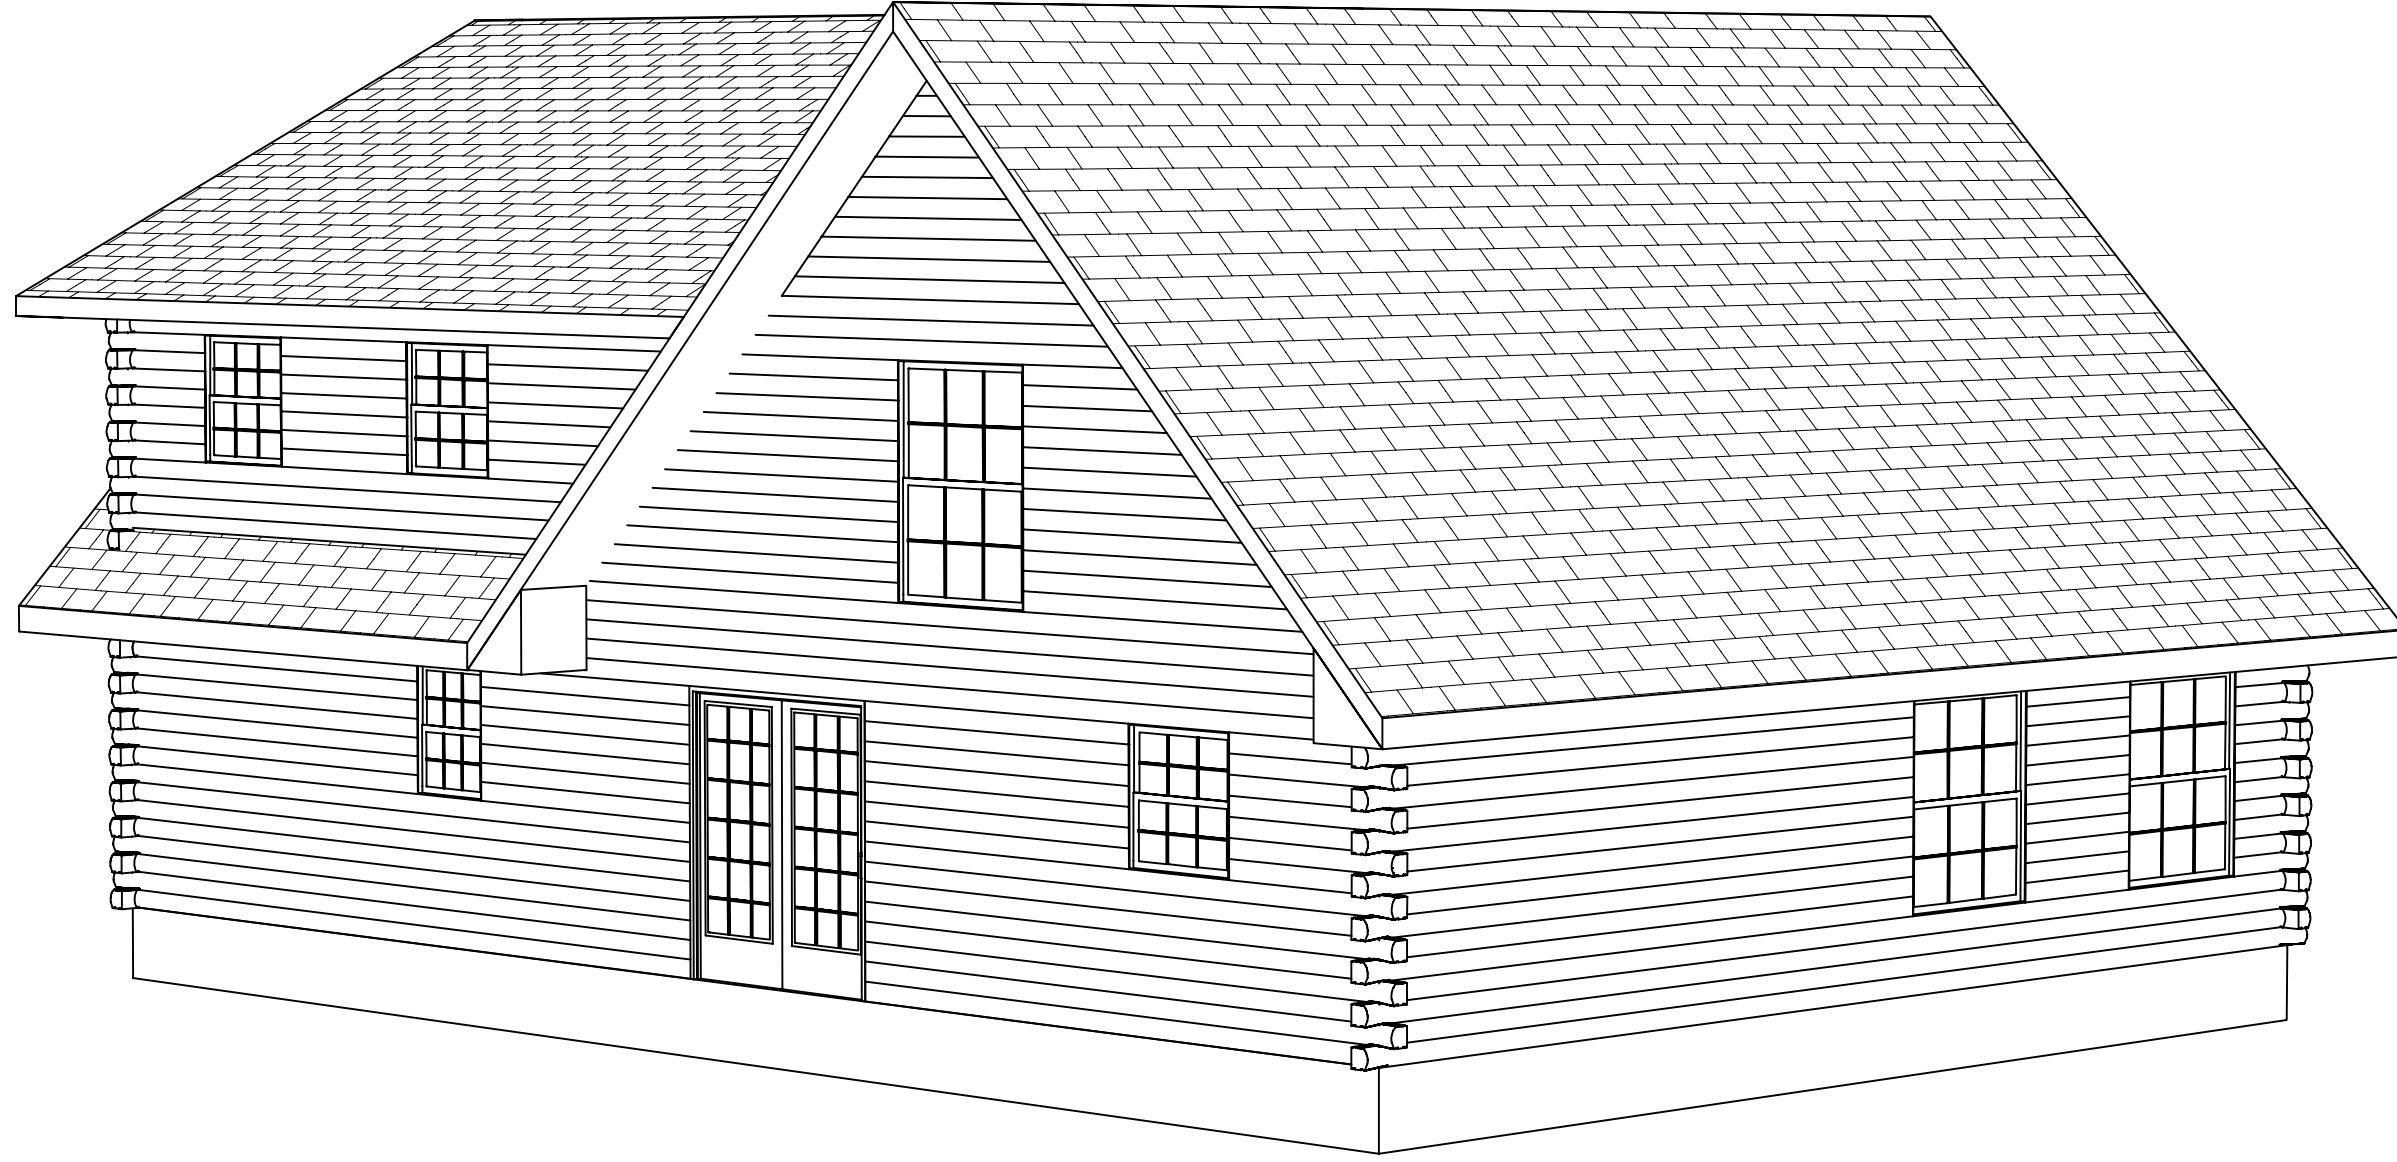

PROJECT NO: 2006-000  
DATE: Jan. 09, 2006  
SHT SUBSET: 3D Reqs & Elevs  
DRAWN BY: DB  
CHK'D BY: |REV. NO: 0  
SCALE: N.T.S.

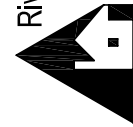
 Riverbend Log Homes  
P: 1-800-561-3000  
P: 1-506-575-2255  
F: 1-506-575-2855  
[www.riverbendloghomes.com](http://www.riverbendloghomes.com)


PROJECT NAME: Standard Bedford  
BLDG. STYLE: -----

SHEET TITLE: 3D View

SHEET NO: A3


\*Preliminary — Not for Construction\*

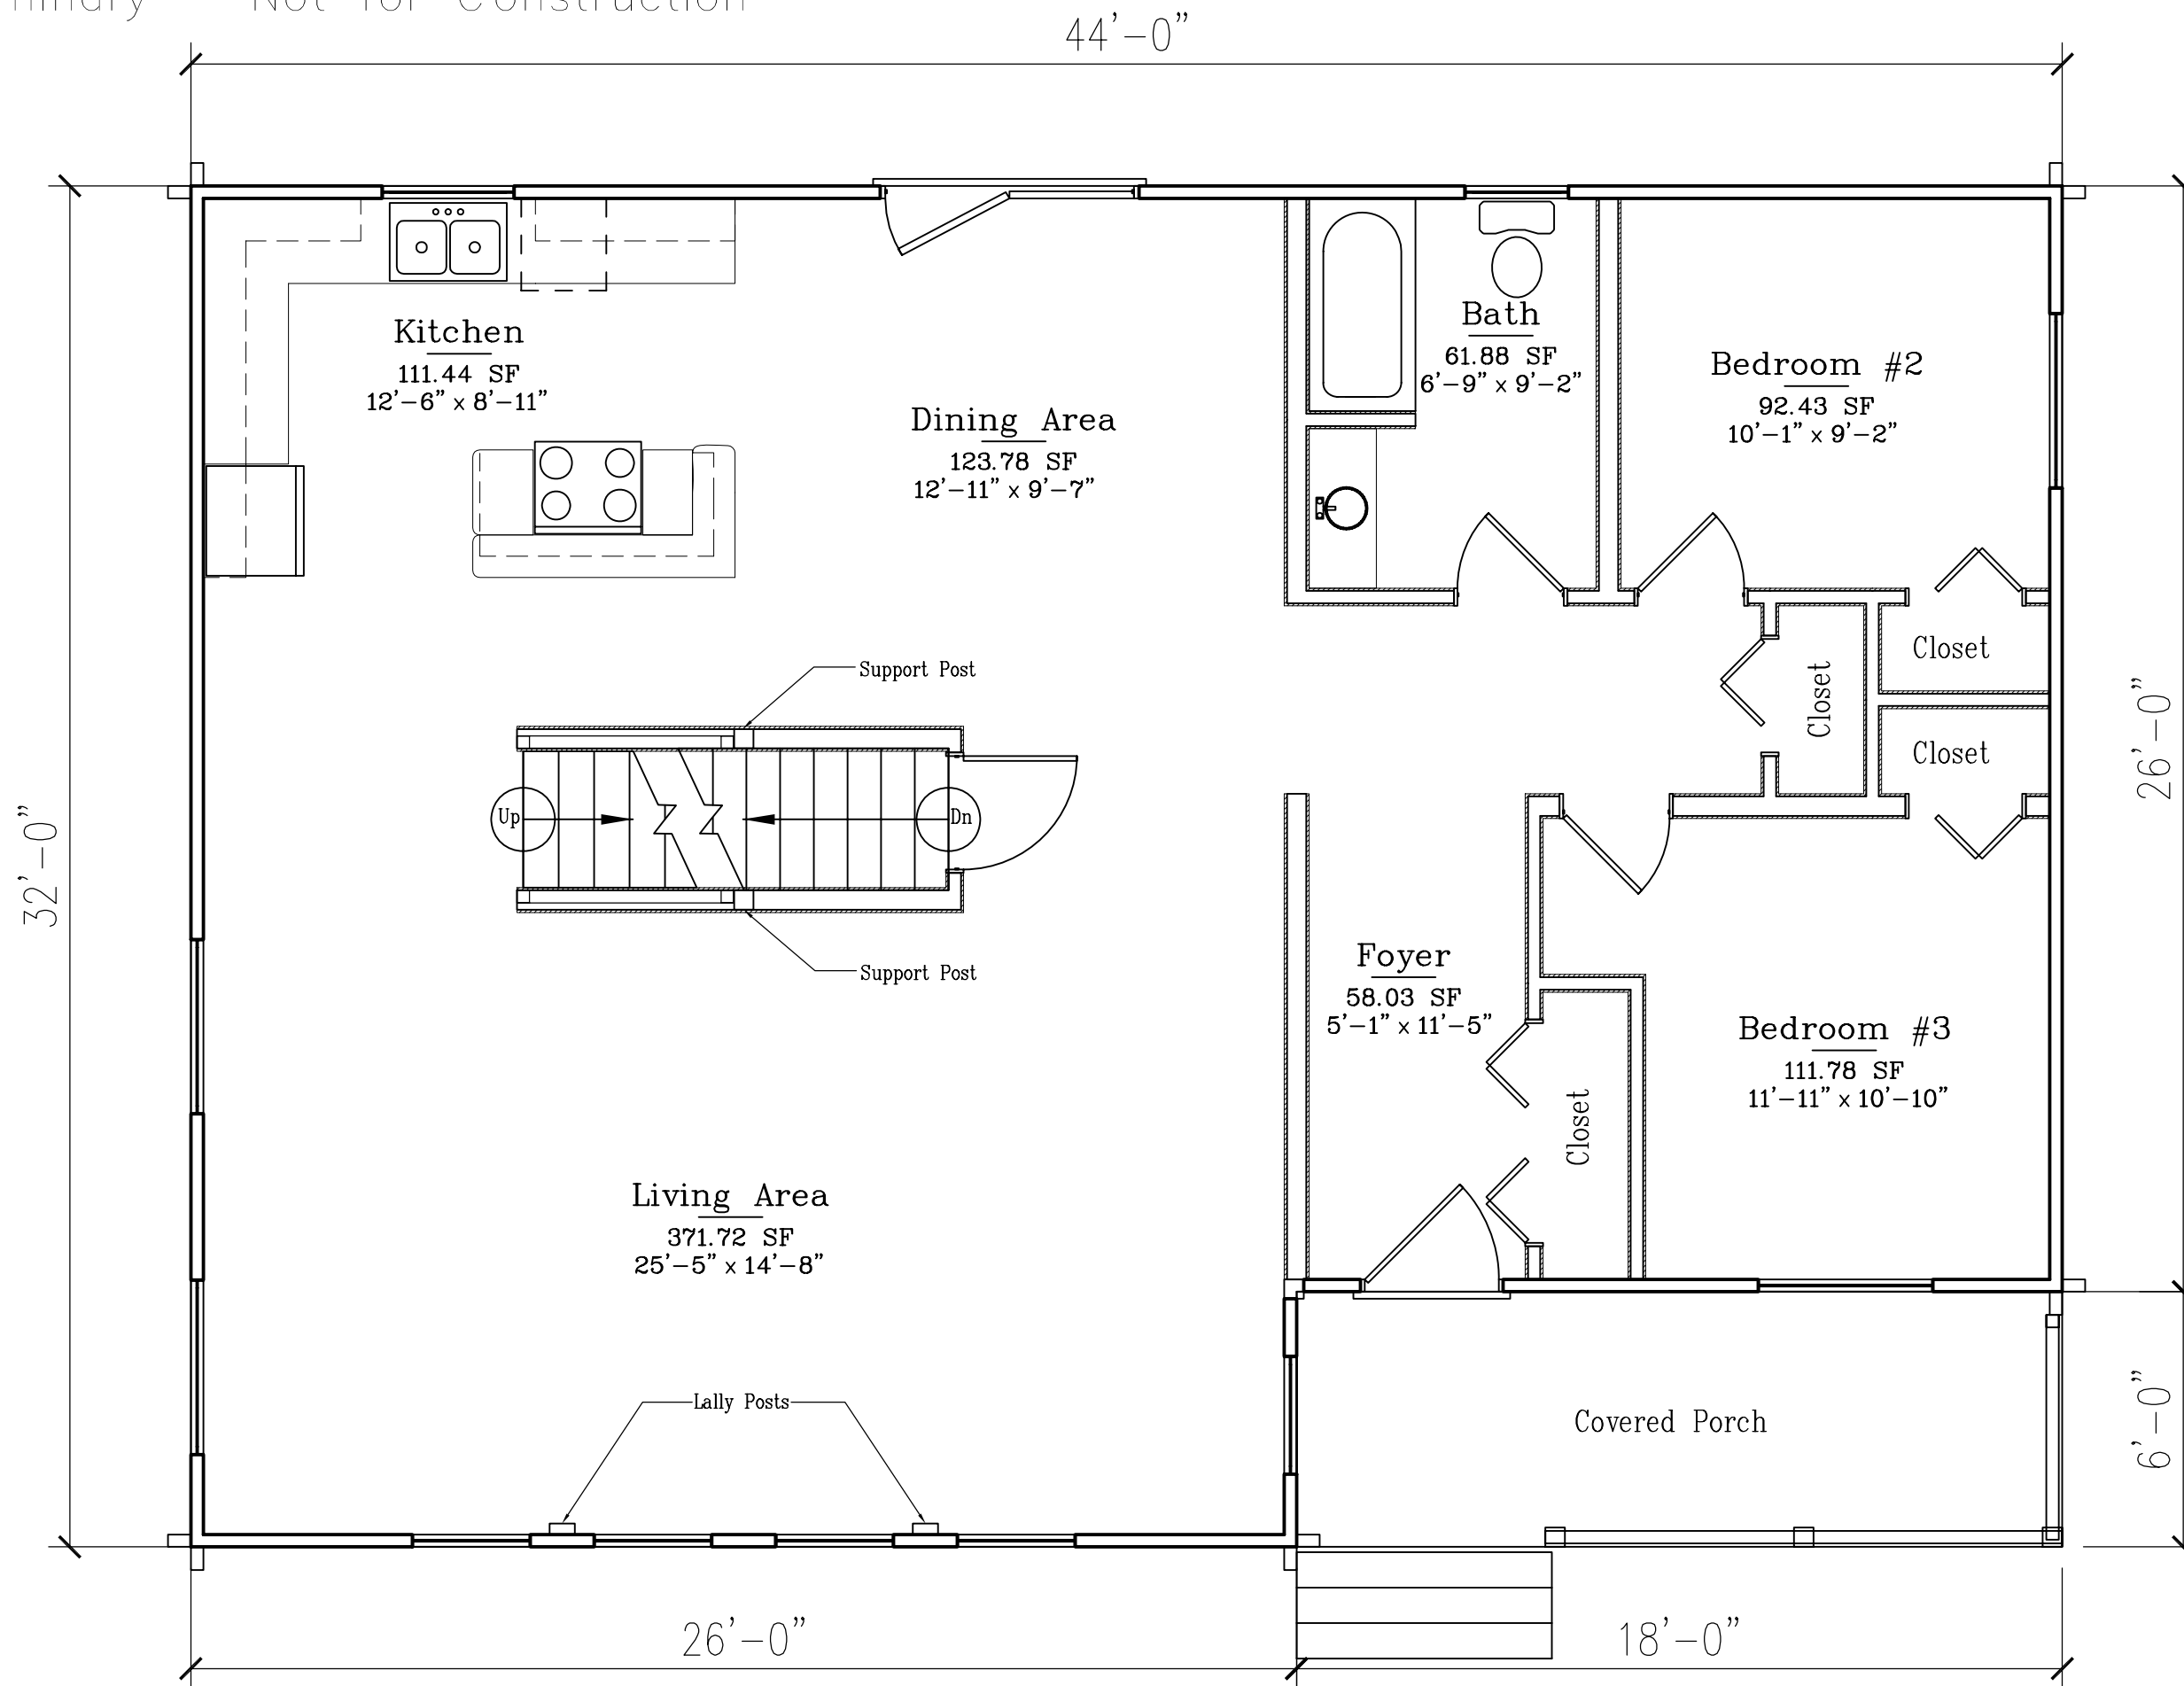

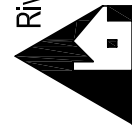PROJECT NO: 2006-000	PROJECT NAME: Standard Bedford	SHEET TITLE: First Floor Plan	SHEET NO: B2
DATE: Jan. 09, 2006	BLDG. STYLE: -----		
SHT SUBSET: Plans			
DRAWN BY: DB			
CHK'D BY: _____			
REV. NO: 0			
SCALE: 1/4" = 1'-0"			
 Riverbend Log Homes P: 1-800-561-3000 F: 1-506-575-2255 www.riverbendloghomes.com			

\*Preliminary — Not for Construction\*

44'-0" Full Shed Dormer

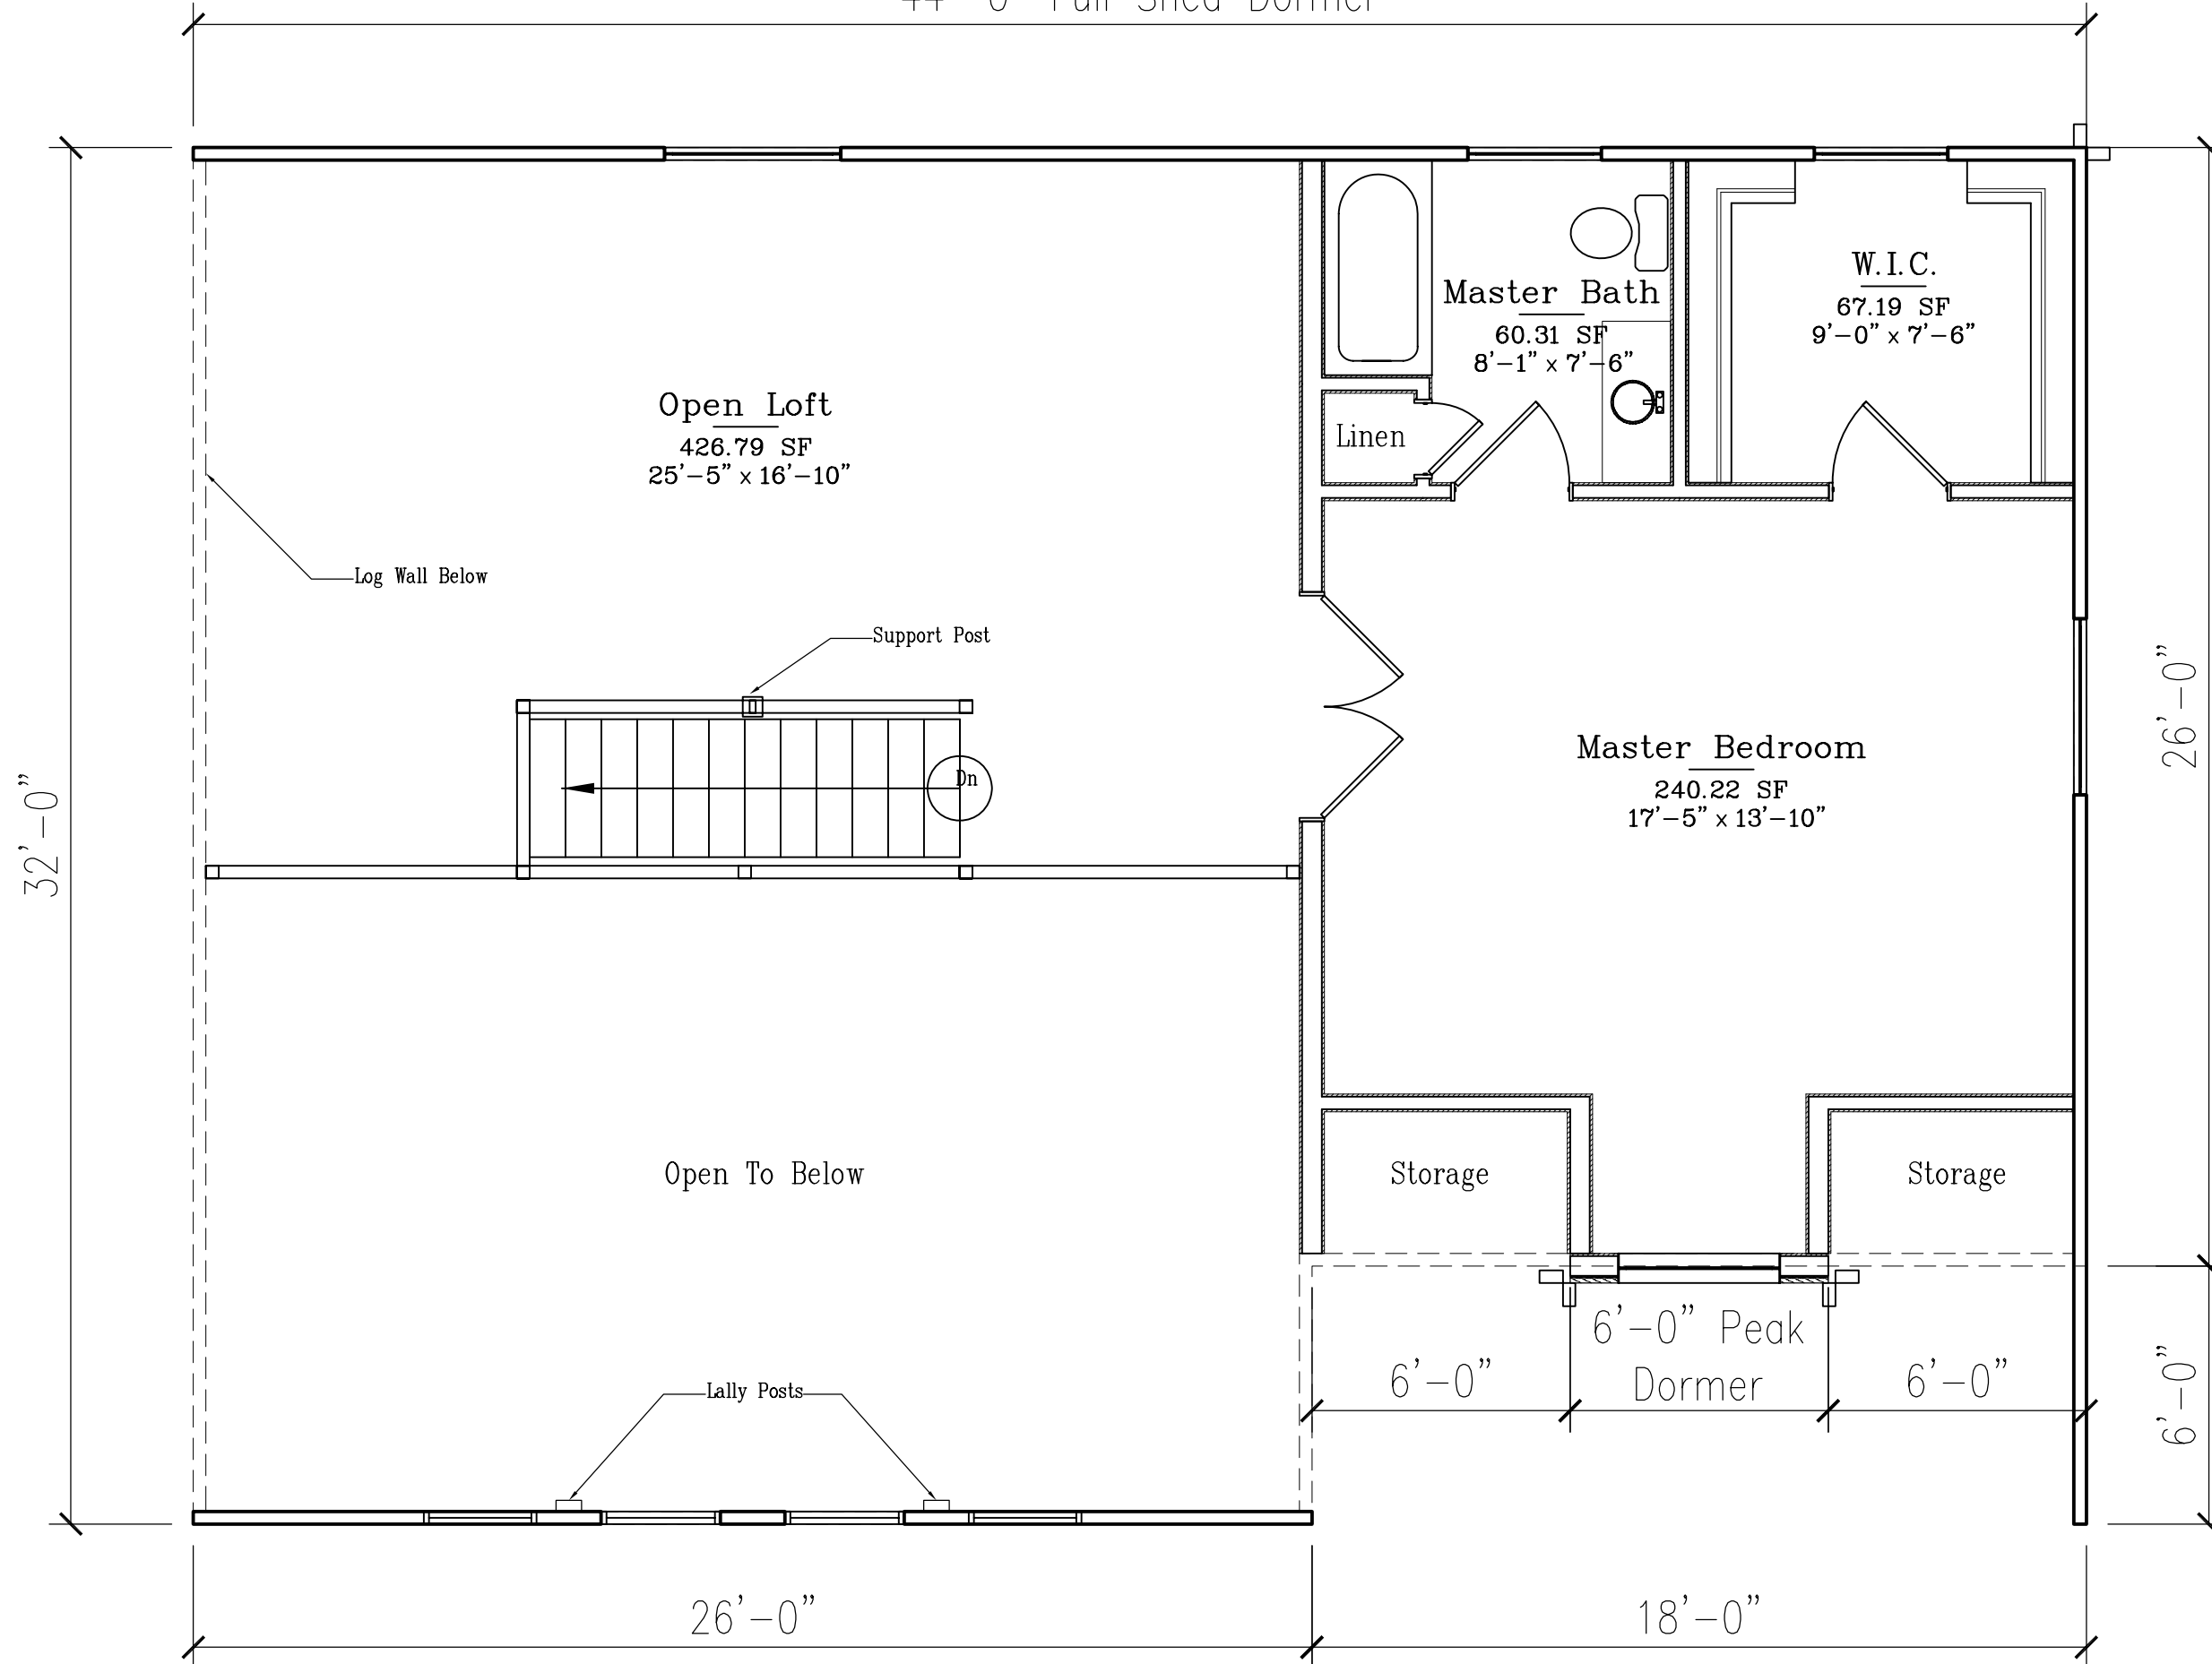

SHEET NO:

B3

SHEET TITLE:

Loft Floor Plan

PROJECT NAME:

Standard Bedford

BLDG. STYLE:

----

Riverbend Log Homes

P: 1-800-561-3000

F: 1-506-575-2255

F: 1-506-575-2855

www.riverbendloghomes.com

PROJECT NO: 2006-000

DATE: Jan. 09, 2006

SHT SUBSET: Plans

DRAWN BY: DB

CHK'D BY: REV. NO: 0

SCALE: 1/4" = 1'-0"